

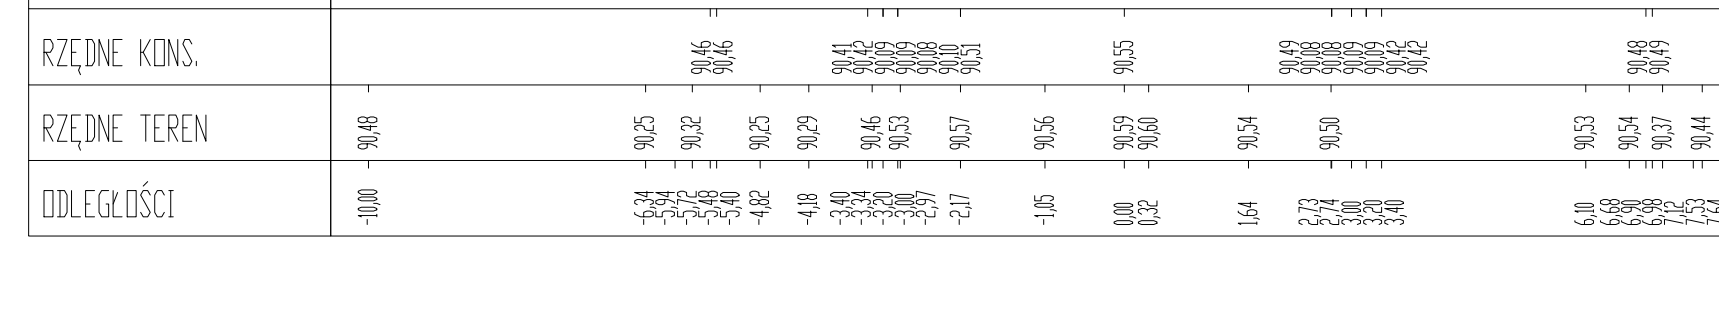


Month	Number of Cases (Millions)
Mar-20	0.1
Apr-20	0.5
May-20	1.5
Jun-20	1.0
Jul-20	0.8
Aug-20	0.7
Sep-20	0.6
Oct-20	0.5
Nov-20	0.4
Dec-20	0.3
Jan-21	0.2
Feb-21	0.1
Mar-21	3.5

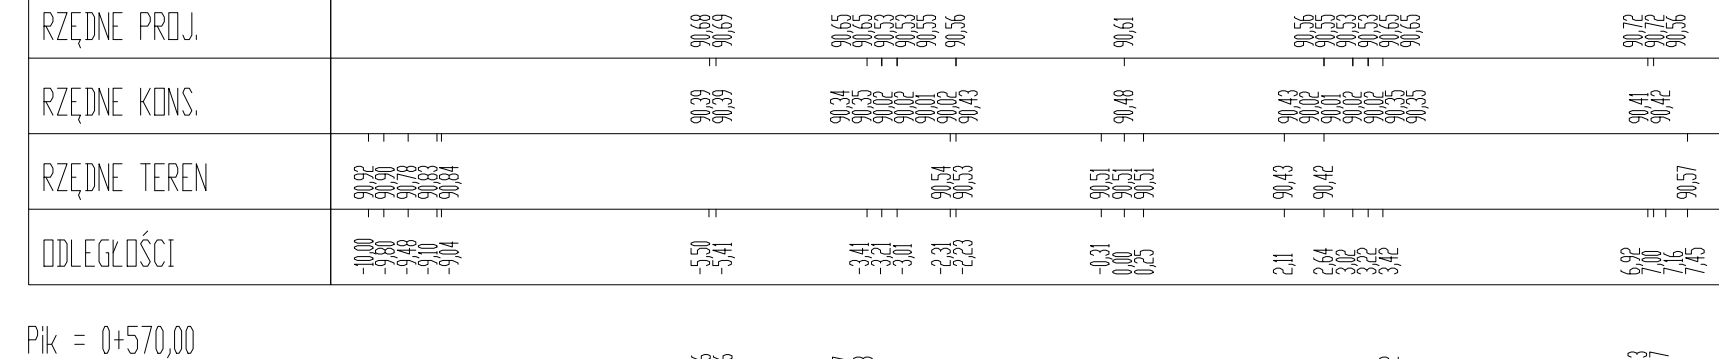

Pik = 0+575,
Skala 1:100/1

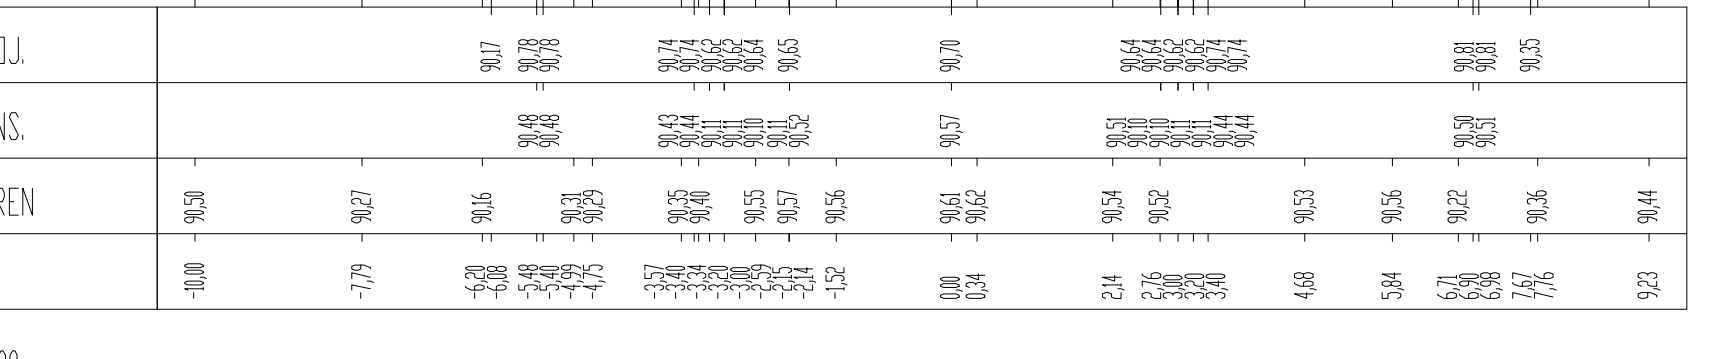


Architectural drawing of a roof plan (Dachstuhl) showing a gabled roof structure. The drawing includes various dimensions and a scale of 1:100/1.



Dimensions shown:

- 0.00
- 0.01
- 0.06
- 0.07
- 0.05
- 0.02
- 0.03
- 0.10
- 0.04
- 0.02
- 0.09
- 0.03
- 0.02
- 0.16
- 0.00

Scale: Skala 1:100/1


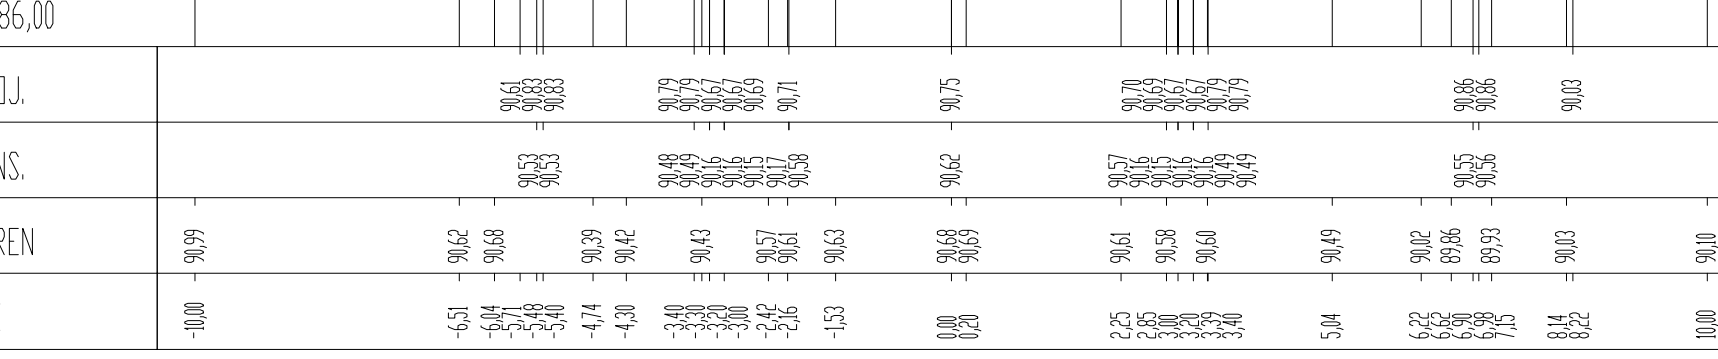


Pik = 0+625
Skala 1:100/1

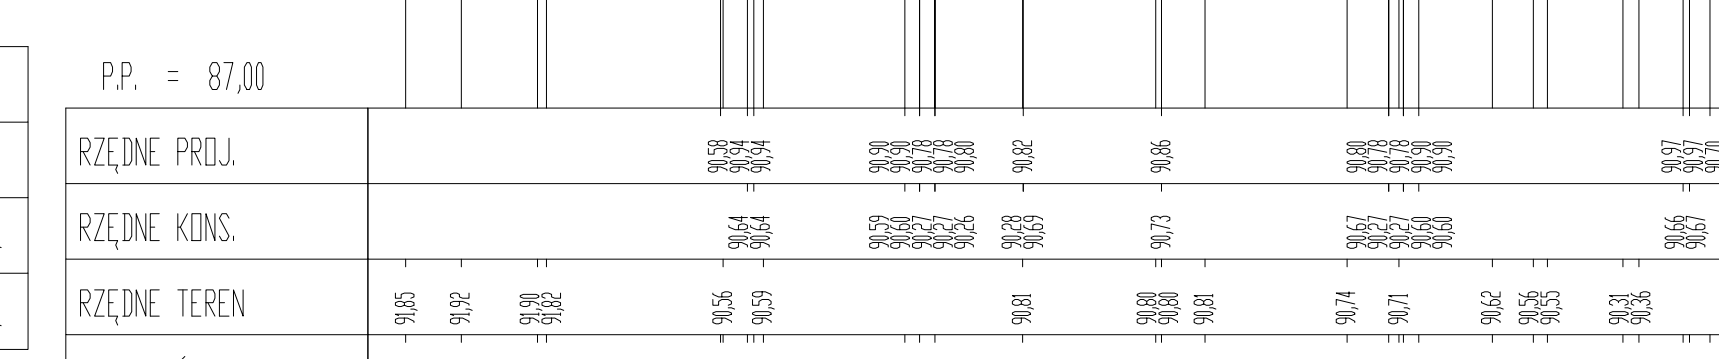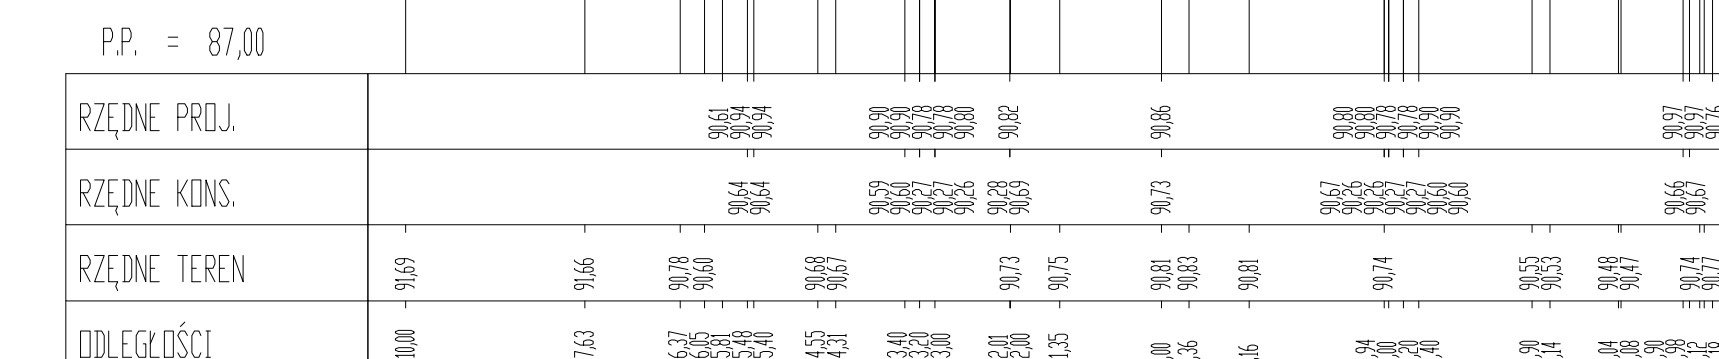

Number of nodes	Frequency
0	0.00
10	0.00
20	0.00
30	0.00
40	0.00
50	0.00
60	0.00
70	0.00
80	0.00
90	0.00
100	0.00

Skala

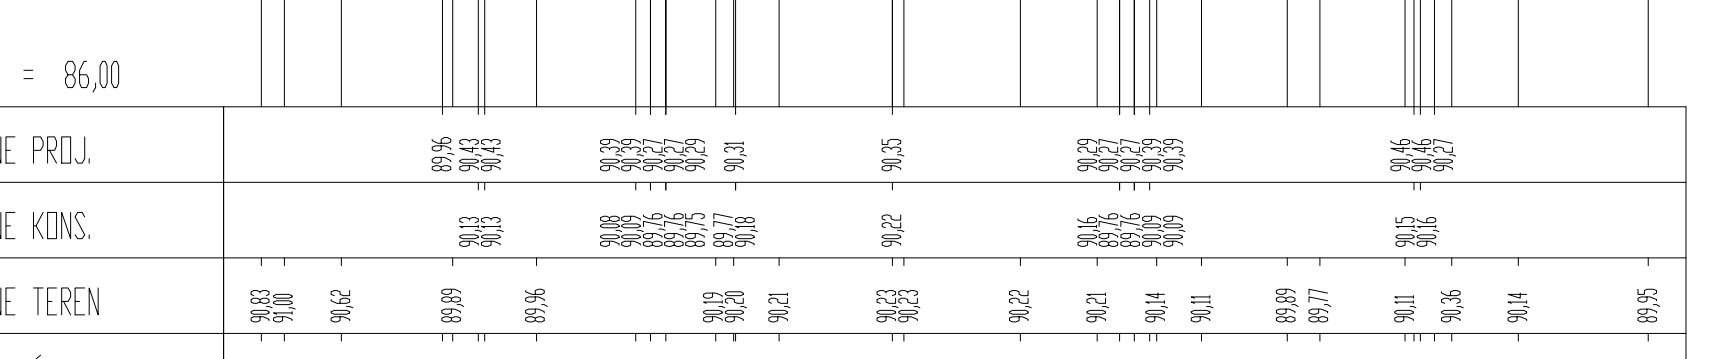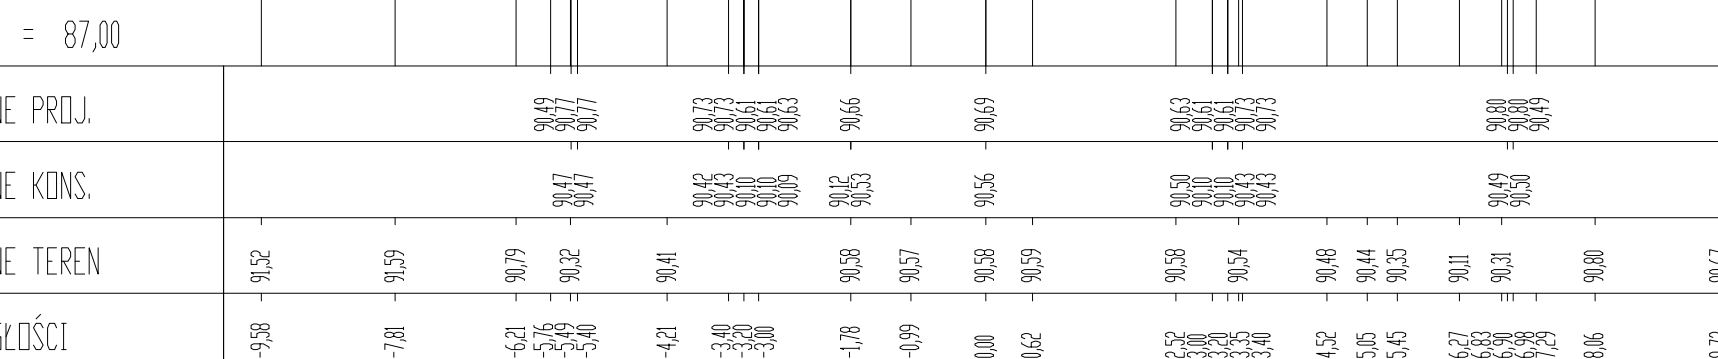

$\frac{1}{2}$	$\frac{1}{3}$	$\frac{1}{4}$	$\frac{1}{100}$
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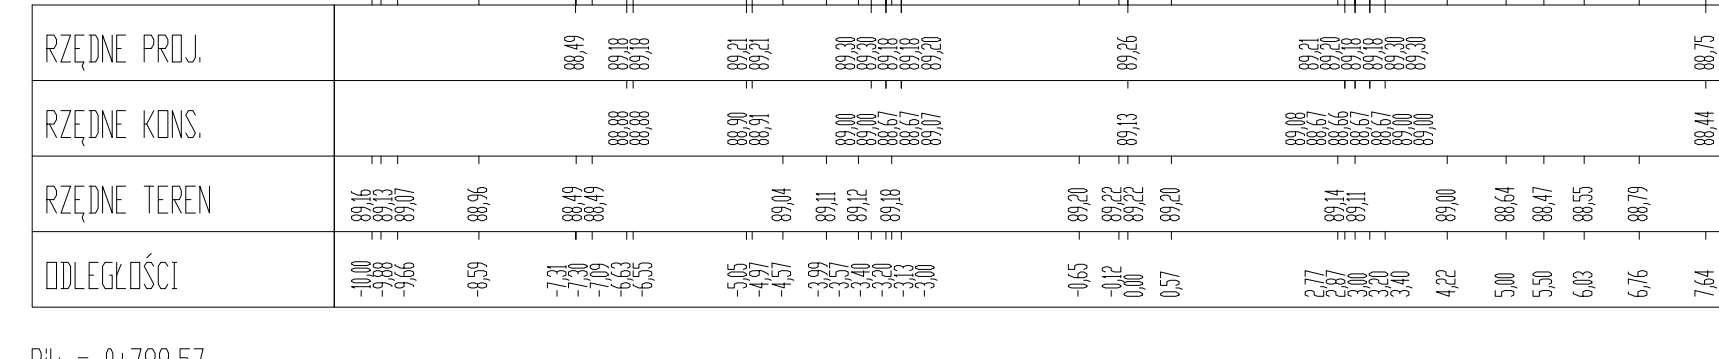
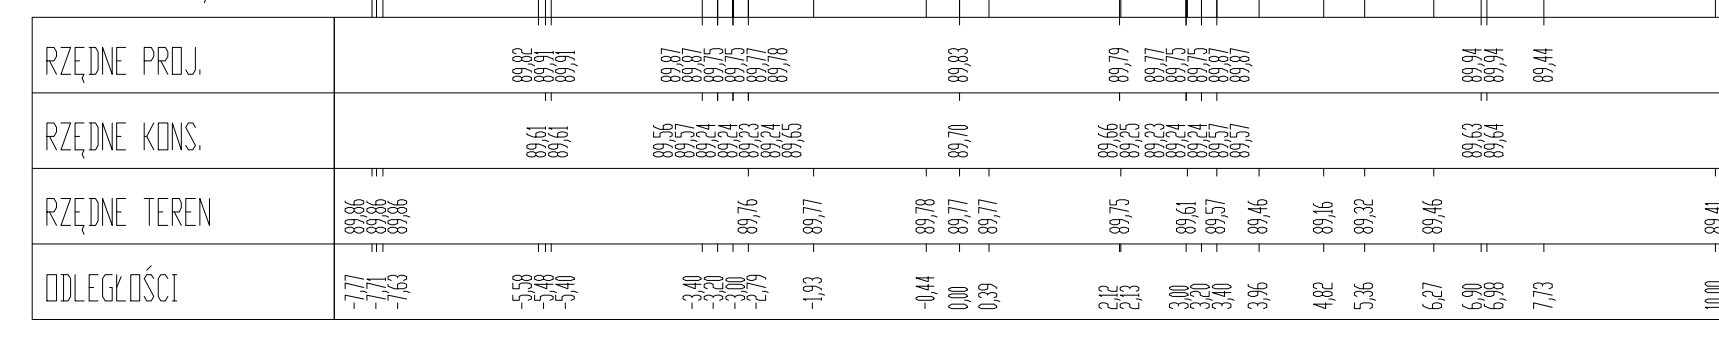
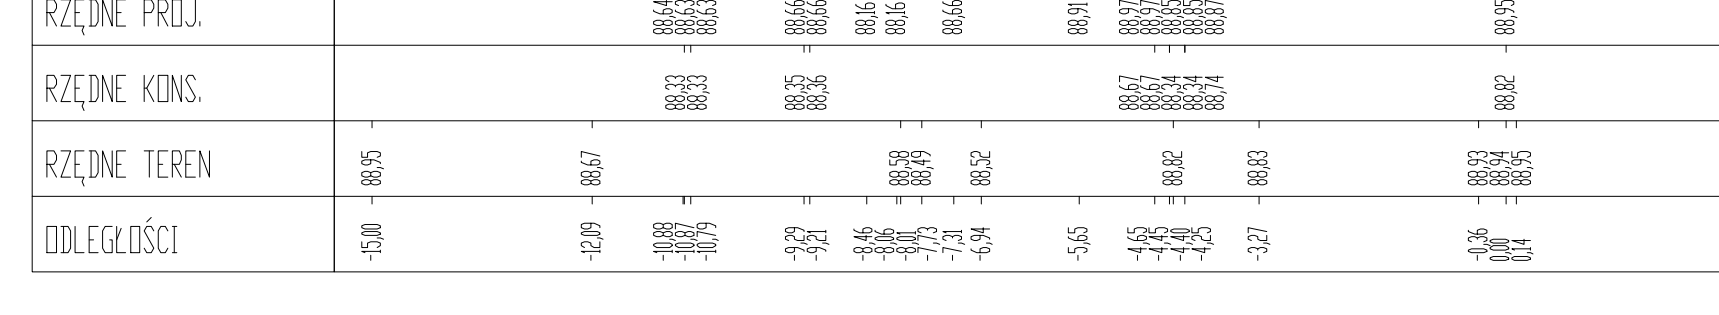
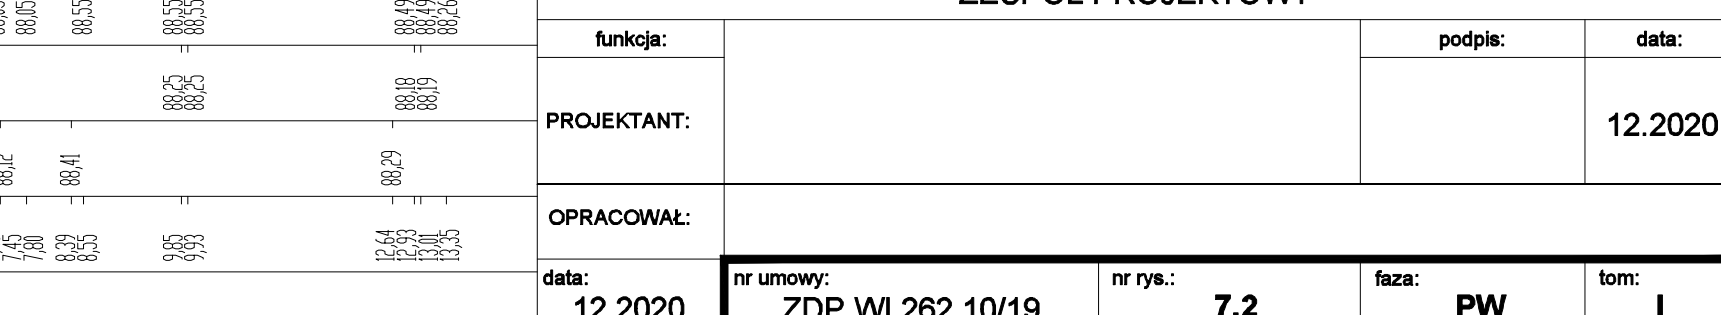
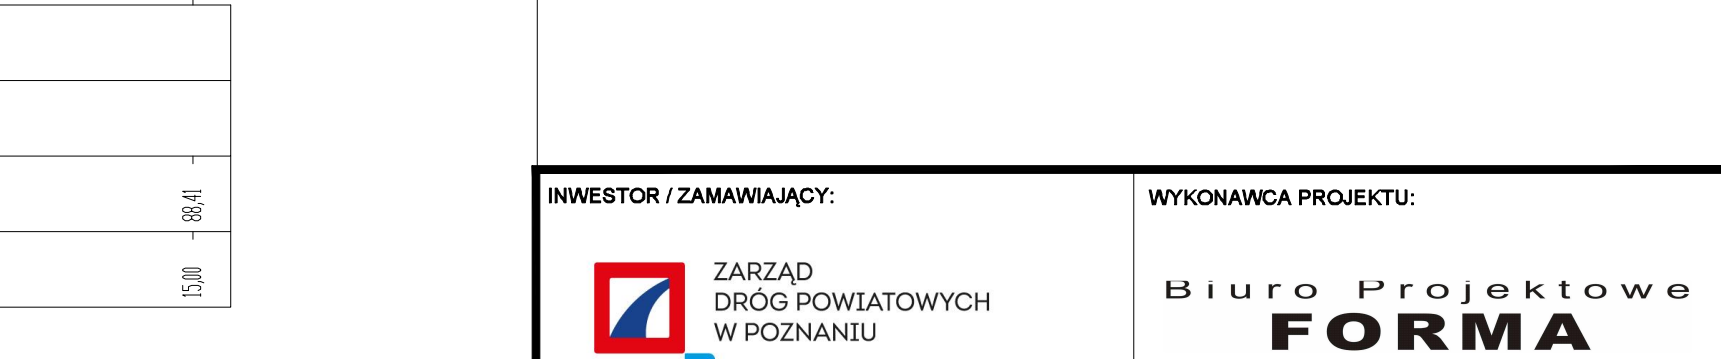

[illegible]

Figure 10 is a cross-sectional diagram of a bridge deck. It shows a central box girder with a top flange, a bottom flange, and a web. The reinforcement is shown as a series of lines within the concrete structure. The diagram is labeled with various dimensions and reinforcement details. The top flange has a width of 0.27 and a height of 0.02. The bottom flange has a width of 0.02 and a height of 0.02. The web has a thickness of 0.02. The reinforcement is shown as a series of lines within the concrete structure. The diagram is labeled with various dimensions and reinforcement details.



<p>INWESTOR / ZAMAWIAJĄCY:</p>  <p>ZARZĄD DRÓG POWIATOWYCH W POZNANIU</p>	<p>WYKONAWCA PROJEKTU:</p> <p>Biuro Projektowe FORMA</p>
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NAZWA INWESTYCJI : PRZEBUDOWA ULICY OTUSKIEJ W BUKU, WIELKIEJ WSI

TREŚĆ RYSUNKU:

PRZEKROJE POPRZECZNE

		ZESPÓŁ PROJEKTOWY			
funkcja:				podpis:	data:
PROJEKTANT:					12.2020
OPRAWCAŁ:					
data:	nr umowy:	nr rys.:	faza:	tom:	
12.2020	ZDP.WI.262.10/19	7.2	PW	I	